

Exhibit Y - St. Tammany South Central Site LA SHPO Letter

February 11, 2016

Mr. Phil Boggan Interim Assistant Secretary Louisiana Office of Cultural Development P.O. Box 44247 Baton Rouge, LA 70804-44247 No known historic properties will be affected by this undertaking. Therefore, our office has no objection to the implementation of this project. This effect determination could change should new information come to our attention.

Hilbosan

Phil Boggan State Historic Preservation Officer

Date

05/03/2016

Subject: Archeological Sites, Historic Structures Or Other Protected Areas Abita Springs Sod Farm, St. Tammany Parish

Dear Mr. Boggan:

Pivotal Engineering LLC requests confirmation from the Louisiana Office of Cultural Development that the site currently used as a sod farm has no known archeological sites, historic structures or other protected areas within property. The site is approximately 352 acres and is located as shown in Exhibit A/Figure 1. The footprint and GPS coordinates of the site are provided on Figure 2. This request is strictly for future economic development opportunities for the property.

1. Name of federal agency, agency involvement (Funding, license\permit, etc. and description of the undertaking (Detailed description of project).

Response:

The owners of the property are submitting an application to the Louisiana Economic Development for a Certified Site.

2. Applicant contact information (Name, address, phone number and email address).

Response:

Fred Goodson 916 Morgan Bluff Rd Pearl River, LA 70452 fhgoodson@bellsouth.net

3. Agency contact information (Name, address, phone number and email address).

Response:

Larry Henson Director, Business Intelligence 1051 North Third Street Baton Rouge, LA 70802-5239 larry.henson@la.gov 225.342.1135

4. Description of the Area of Potential Effects (APE). The APE can be direct or indirect. It is defined as "the geographic area or areas within which an undertaking may cause changes in the character or use of historic properties, if any such properties exist." (Include the latitude\longitude of the undertaking location and APE)

Response: The project is an existing sod farm.

(30°26'35.46"N, 89°58'6.63"W)

Refer to Figures 1 and 2 for location and project limits (APE).

No historic properties are believed to be on the site

5. Description of all historic properties within and adjacent to the APE. The historic standing structure is any structure fifty years of age and older. Under Section 106, it is the responsibility of the federal agency or its designee to identify all structures listed or eligible for listing in the National Register of Historic Places.

Response: No historic properties are known to exist with the project area.

- 6. Detailed project scope of work including design plans.
 - o Map and site plan showing APE and exact location of project undertaking.
 - Photographs of the entire APE and project location. Photographs of all historic (fifty years of age and older) within the APE. Buildings should be documented showing diagonal views of front and side and rear and opposite side of the building. All photos should be keyed to a site map and project plans if applicable.

Response: Figures 1 and 2 provide the site location and aerial photograph of the APE. Photographs of the site along with a reference map are also attached.

Thank you for your assistance and send any questions for this request to my attention.


Pivotal Engineering LLC Terry Elnaggar 1515 Poydras St. Suite 1875 New Orleans, LA 70131 (504) 799-3653

Sincerely,

*Terry Elnaggar*Terry Elnaggar P.E.
Principal

Enclosure

St. Tammany South Central Site

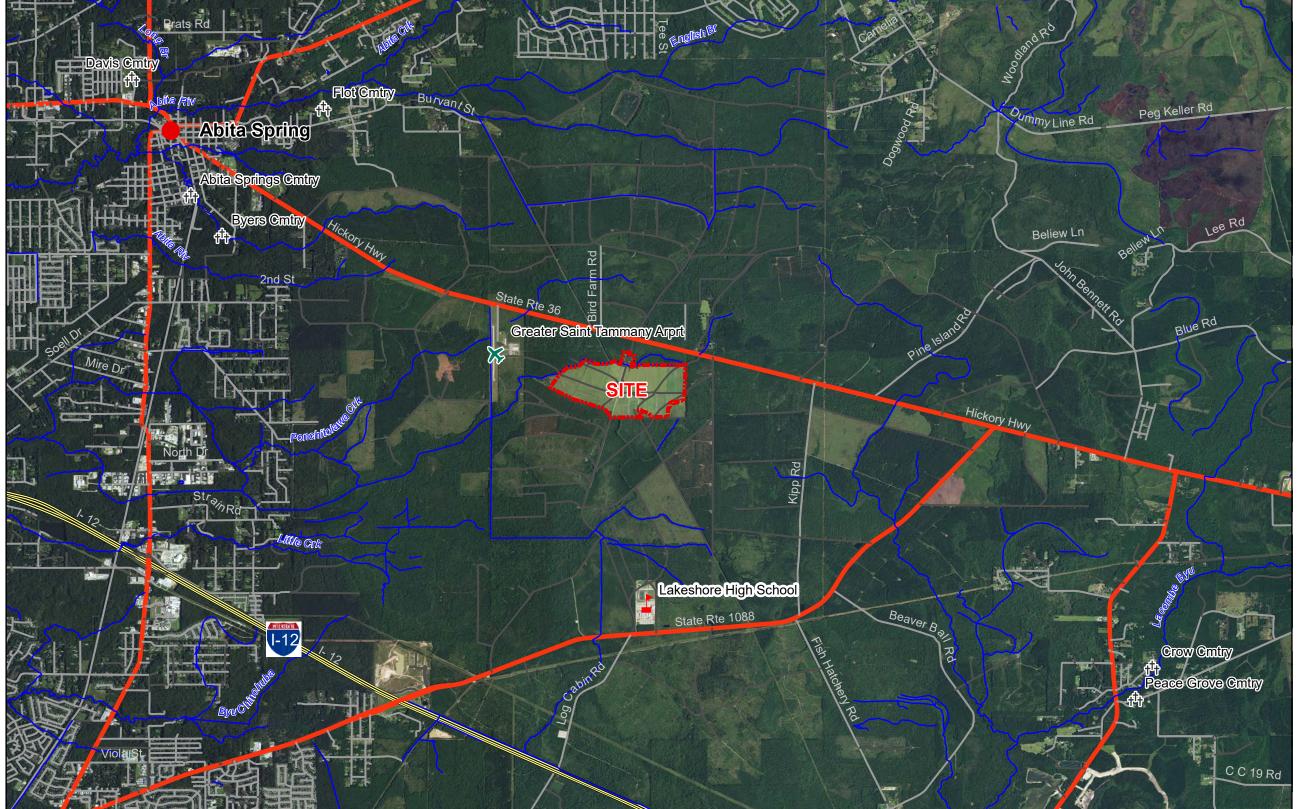

St. Tammany South Central Site Highway 36, Abita Springs, LA





St. Tammany Parish

LEGEND

Site Boundary (351.5 Acres.)



Town



School

Cemetry Stream

Roadway Types

- Unpaved Private Roads

I - Interstate

M - Major Roads

O - I Service Roads

S - State Route

U - US Highway

Figure 1

SCALE 1:63,360

Date:	5/6/2016
Project Number:	15-120
Drawn By:	YS
Checked By:	TE


p i v o t a l

Pivotal Engineering, LLC 1515 Poydras Street, Suite 1875 New Orleans, LA 70112

- 1. No attempt has been made by Pivotal Engineering, LLC to verify site boundary, title, actual legal ownership, deed restrictions, servitudes, easements, or other burdens on the property other than that furnished by the client or his representative.

 2. Transportation data from 2014 TIGER datasets via U.S. Census Bureau

 3. 2015 aerial imagery from USDA-APFO National Agricultural Inventory Project (NAIP).

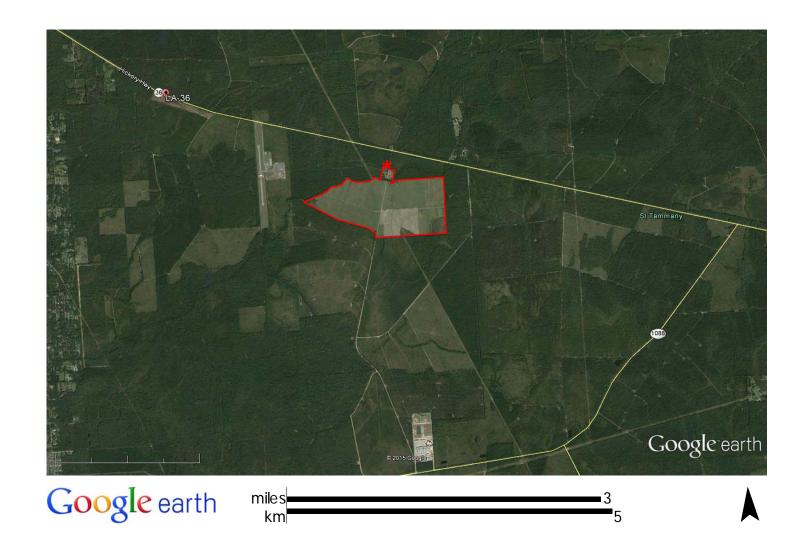

* 30°26'35.46"N 89°58'6.63"W



Drilling and Testing Services Abita Springs, Louisiana

APS Design and Testing, LLC Geotechnical, Environmental, & Construction Materials Testing

Figure 1 General Site Location Plan



Photo 079 from the intersection of the roads in the sod fields



Photo 084 from the intersection of the roads in the sod fields



Photo 104 Abandoned houses. The southernmost one with red door is used as an office now



Photo 105 Equipment and maintenance shed on the east side of the entrance road;



Photo 122 Irrigation well and system. Adjacent abandoned water well. Located in NE sod field



Photo 0129 Debris pile of irrigation equipment in the southwest sod field;